
HERCULES BLOCK Q & R STREET IMPROVEMENT PACKAGE

BAYFRONT BOULEVARD & JOHN MUIR PARKWAY HERCULES, CONTRA COSTA COUNTY, CALIFORNIA

PROJECT NUMBER: SIP-QR-005

OCTOBER 26, 2018 100% CONSTRUCTION DOCUMENTS

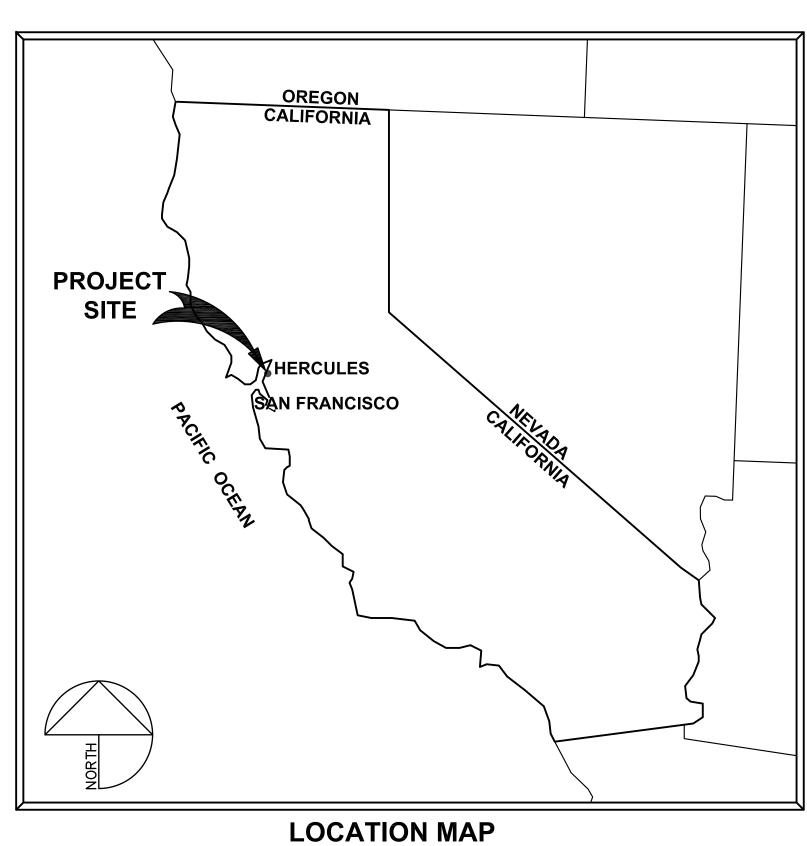

NOT TO SCALE


REVIEWED FOR CONFORMANCE WITH THE <u>CITY OF HERCULES</u> STANDARDS AND SPECIFICATIONS. APPROVAL FOR CONSTRUCTION IS SUBJECT TO THE INFORMATION SHOWN HEREIN. <u>CITY OF HERCULES</u> AND THE UNDERSIGNED ARE NOT RESPONSIBLE FOR ANY ERRORS OR OMISSIONS THAT MAY EXIST ON THESE PLANS.

MIKE ROBERTS, P.E.

PUBLIC WORKS DIRECTOR/CITY ENGINEER

PROJECT TEAM

1936 University Ave, Suite 250 Berkeley, CA 94704 510 343 6400 **DESIGN GROUP** www.parisi-associates.com

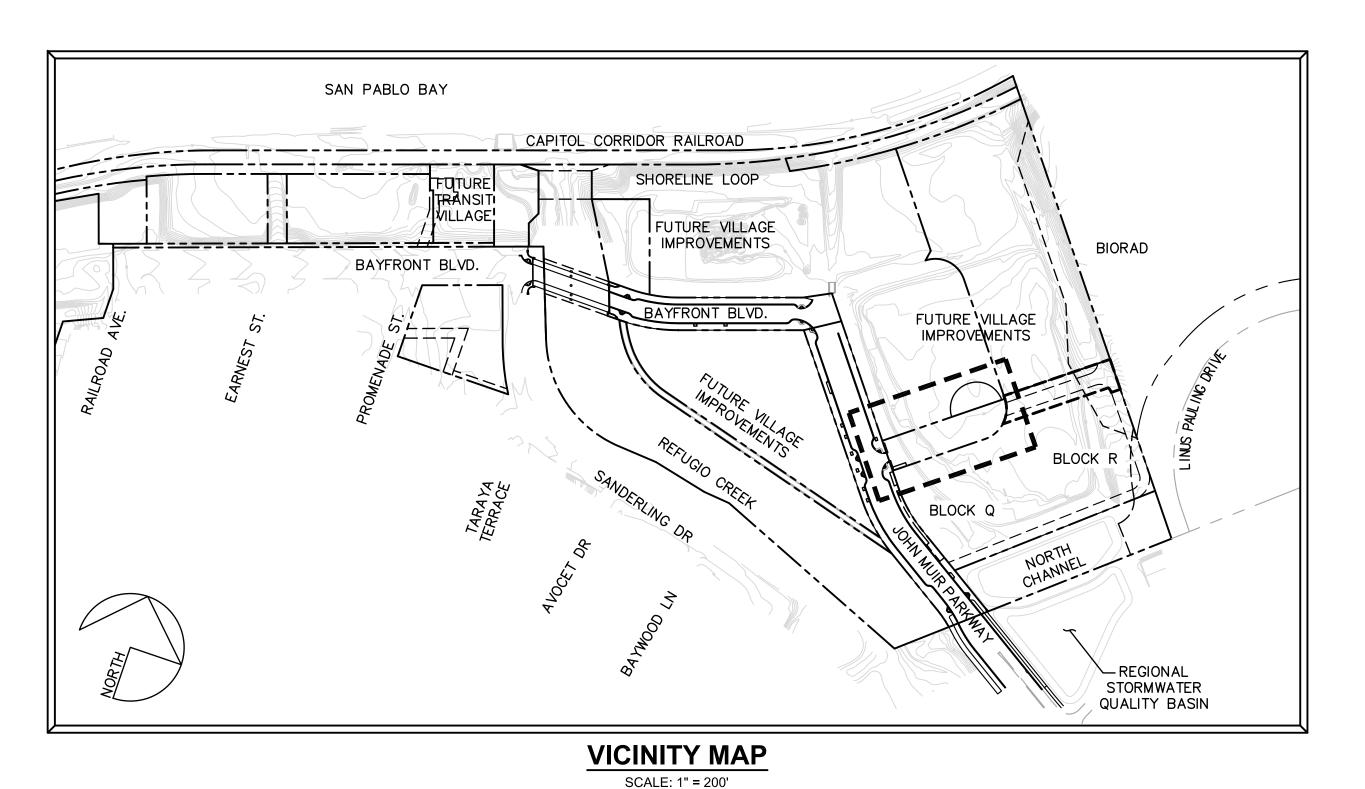

EBMUD STANDARD PLANS

DISTRIBUTION MAIN SERVICE CONNECTIONS, 9020-GB 9496-GB FIRE HYDRANT INSTALLATION

REFERENCED PLANS

BLOCK OR GRADING PERMIT PACKAGE
CONTRA COSTA COUNTY PERMIT NO. XX-XX-XXXX BLOCK OR BUILDING PERMIT PACKAGE
CONTRA COSTA COUNTY PERMIT NO. XX-XX-XXXX

CITY STANDARD PLANS

D-1	PRECAST MANHOLE TYPE 1 BASE
D-3	MANHOLE COVER AND FRAME
D-4.1,4.2,4.3	TYPE A INLET
D-7.1,7.2,7.3	TYPE D INLET
D-8.1,8.2	INLET FRAME AND GRATE
D-9.2	CIRCULAR FRAME AND GRATE FRAME
M 2.1	WOOD HEADER
RW-1.1	STREET SECTION
RW-5.1,5.2,5.3	TRENCH SECTIONS
RW-6.1	CURB AND GUTTER
RW-8.1,8.2	DRIVEWAY RAMP DETAILS
RW-11.1,11.2	DOWELING DETAILS FOR CURB AND SIDEWALK
RW-13.1	STREET NAME SIGN
RW-15.1	UTILITY LOCATIONS
RW-16.1,16.2,16.3	SIGNING AND STRIPING STANDARDS
RW-18.1	CROSSWALK/STOP BAR INSTALLATION

FIRE HYDRANT MARKER

RW-22.1


INDEX OF SHEETS


SHEET	PAGE	<u>DESCRIPTION</u>
C-10	1	TITLE SHEET
C-20	2	TYPICAL SECTIONS
C-30	3	EXISTING CONDITIONS AND DEMOLITION PLAN
C-40	4	LAYOUT PLAN AND IMPROVEMENT CALLOUTS
C-50	5	ENLARGED GRADING PLAN
C-51	6	CURB RETURN PROFILES
C-52	7	GRADING PLAN AND CENTERLINE PROFILE
C-60	8	UTILITY PLAN AND PROFILE
C-70	9	EROSION CONTROL PLAN
C-80	10	FIRE ACCESS PLAN
C-90	11	CONSTRUCTION DETAILS
INT1	12	JOINT TRENCH INTENT TITLE SHEET
INT2	13	JOINT TRENCH INTENT





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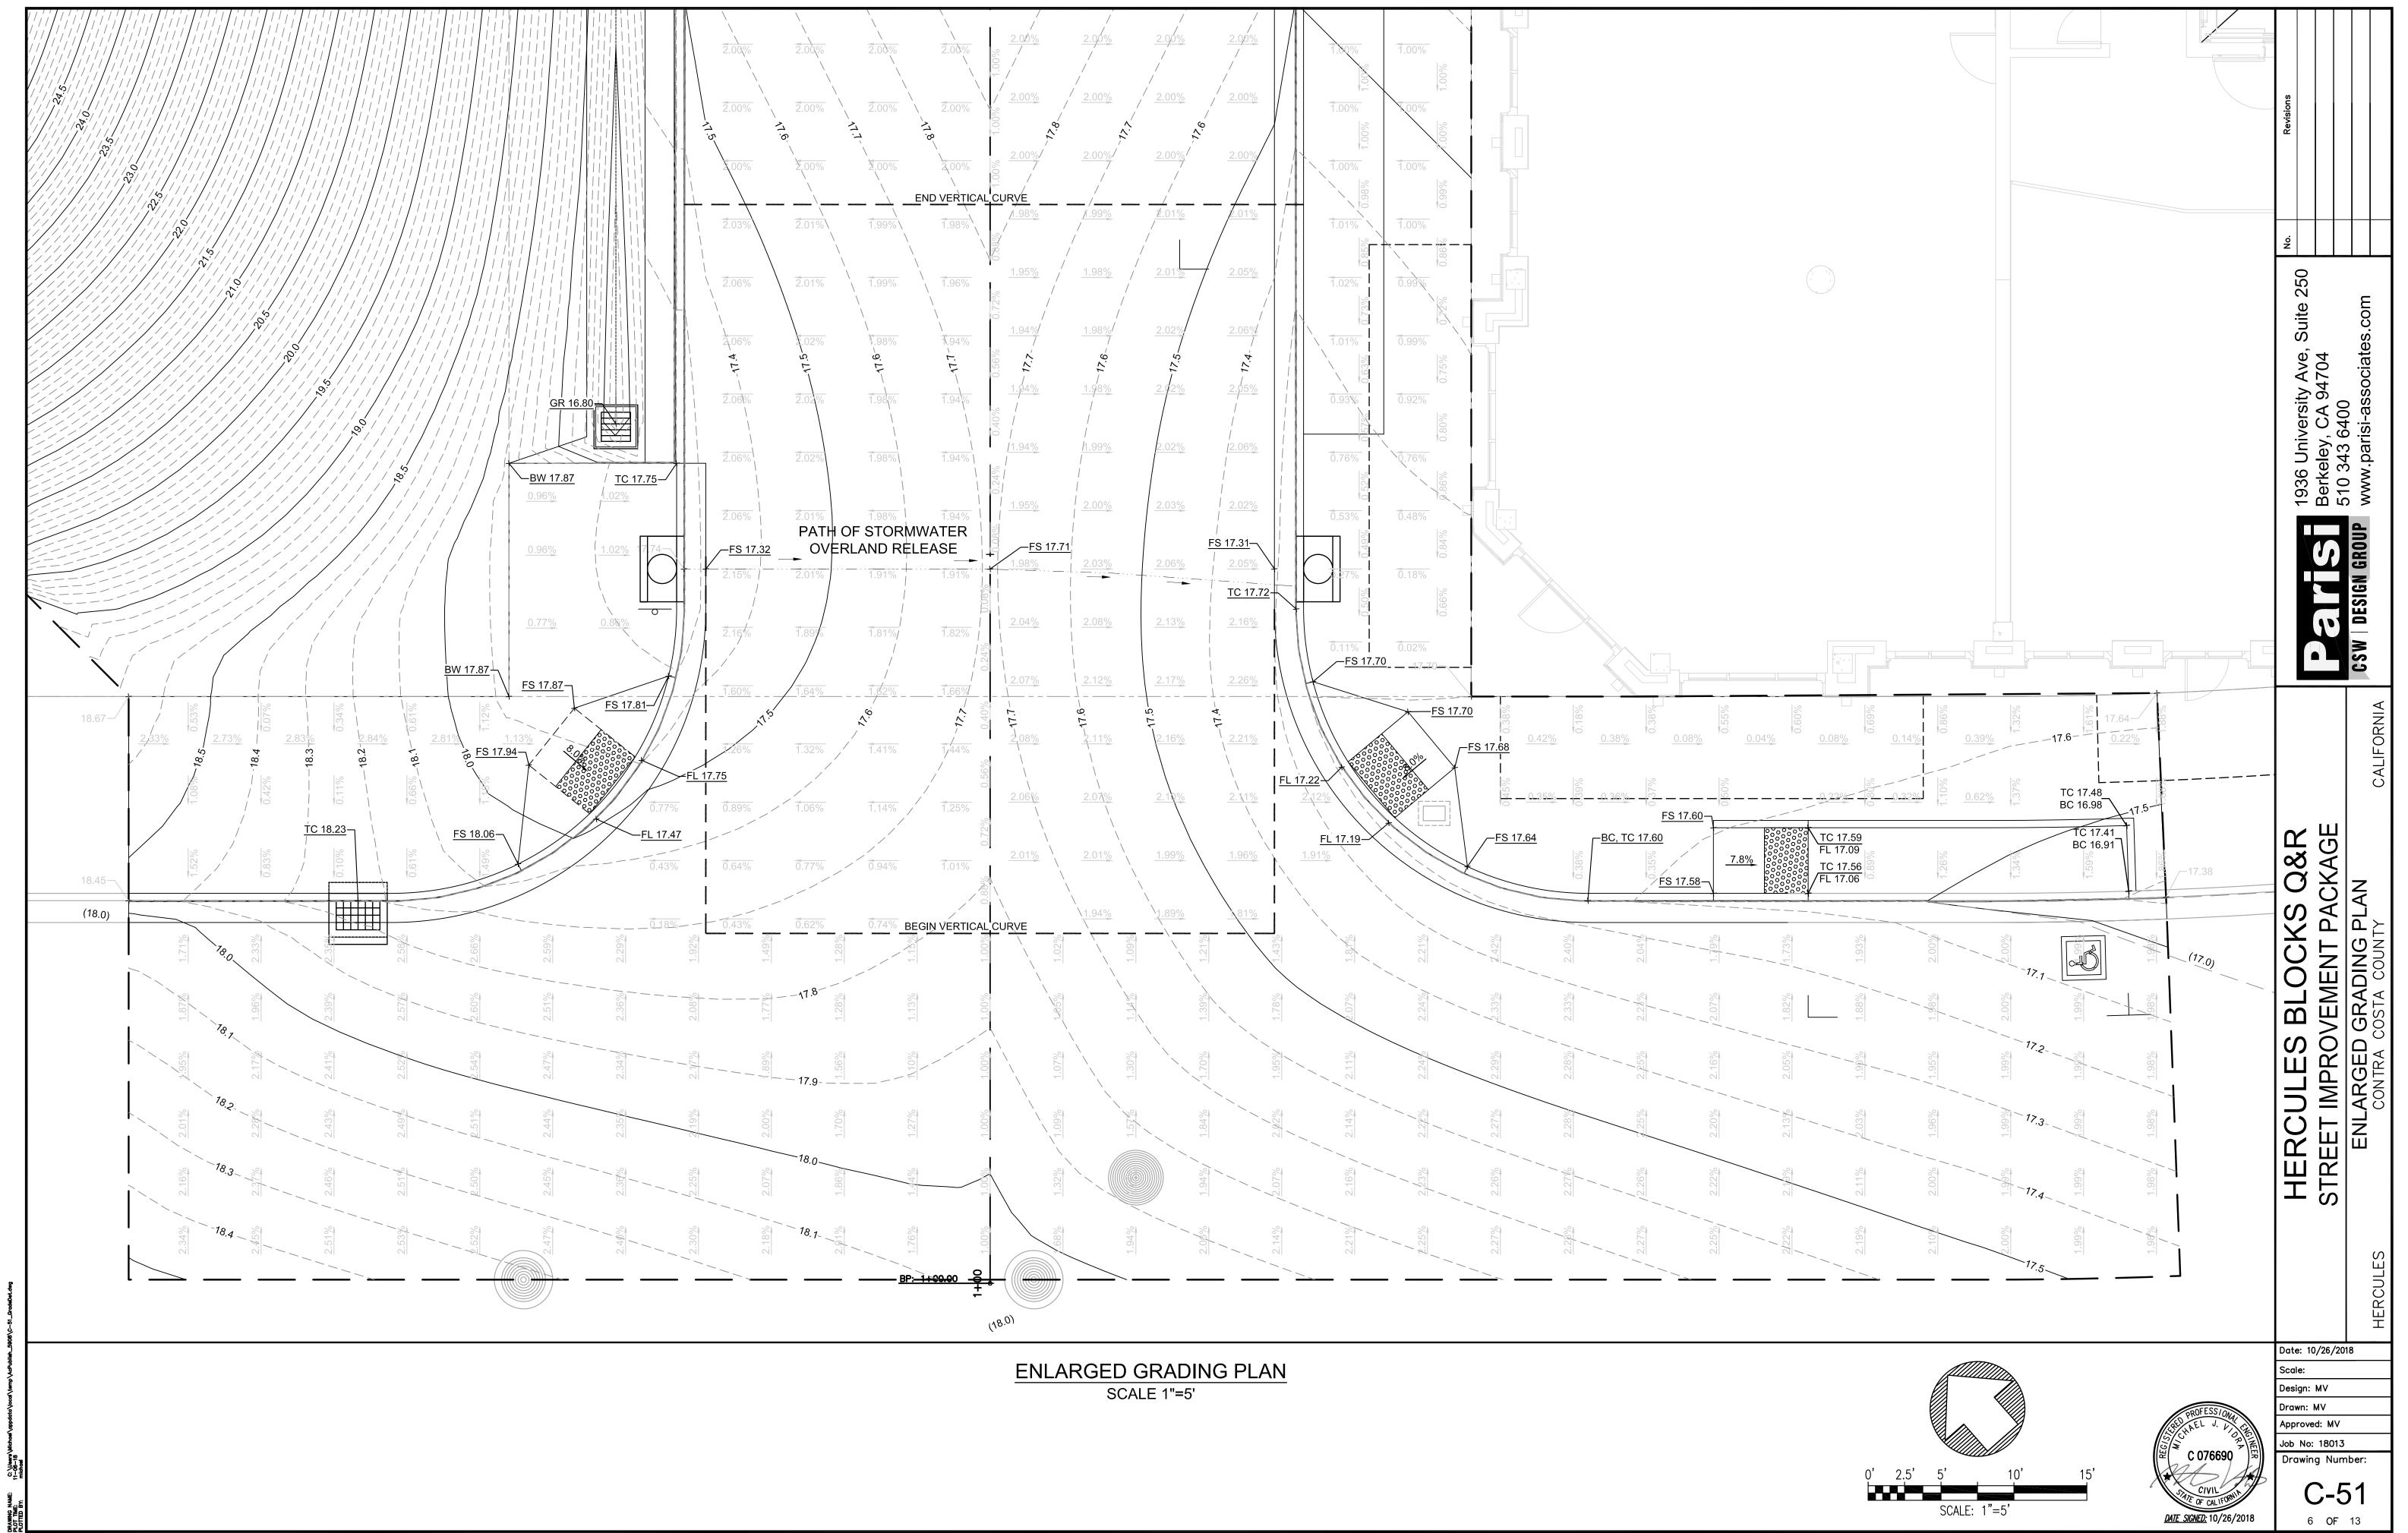
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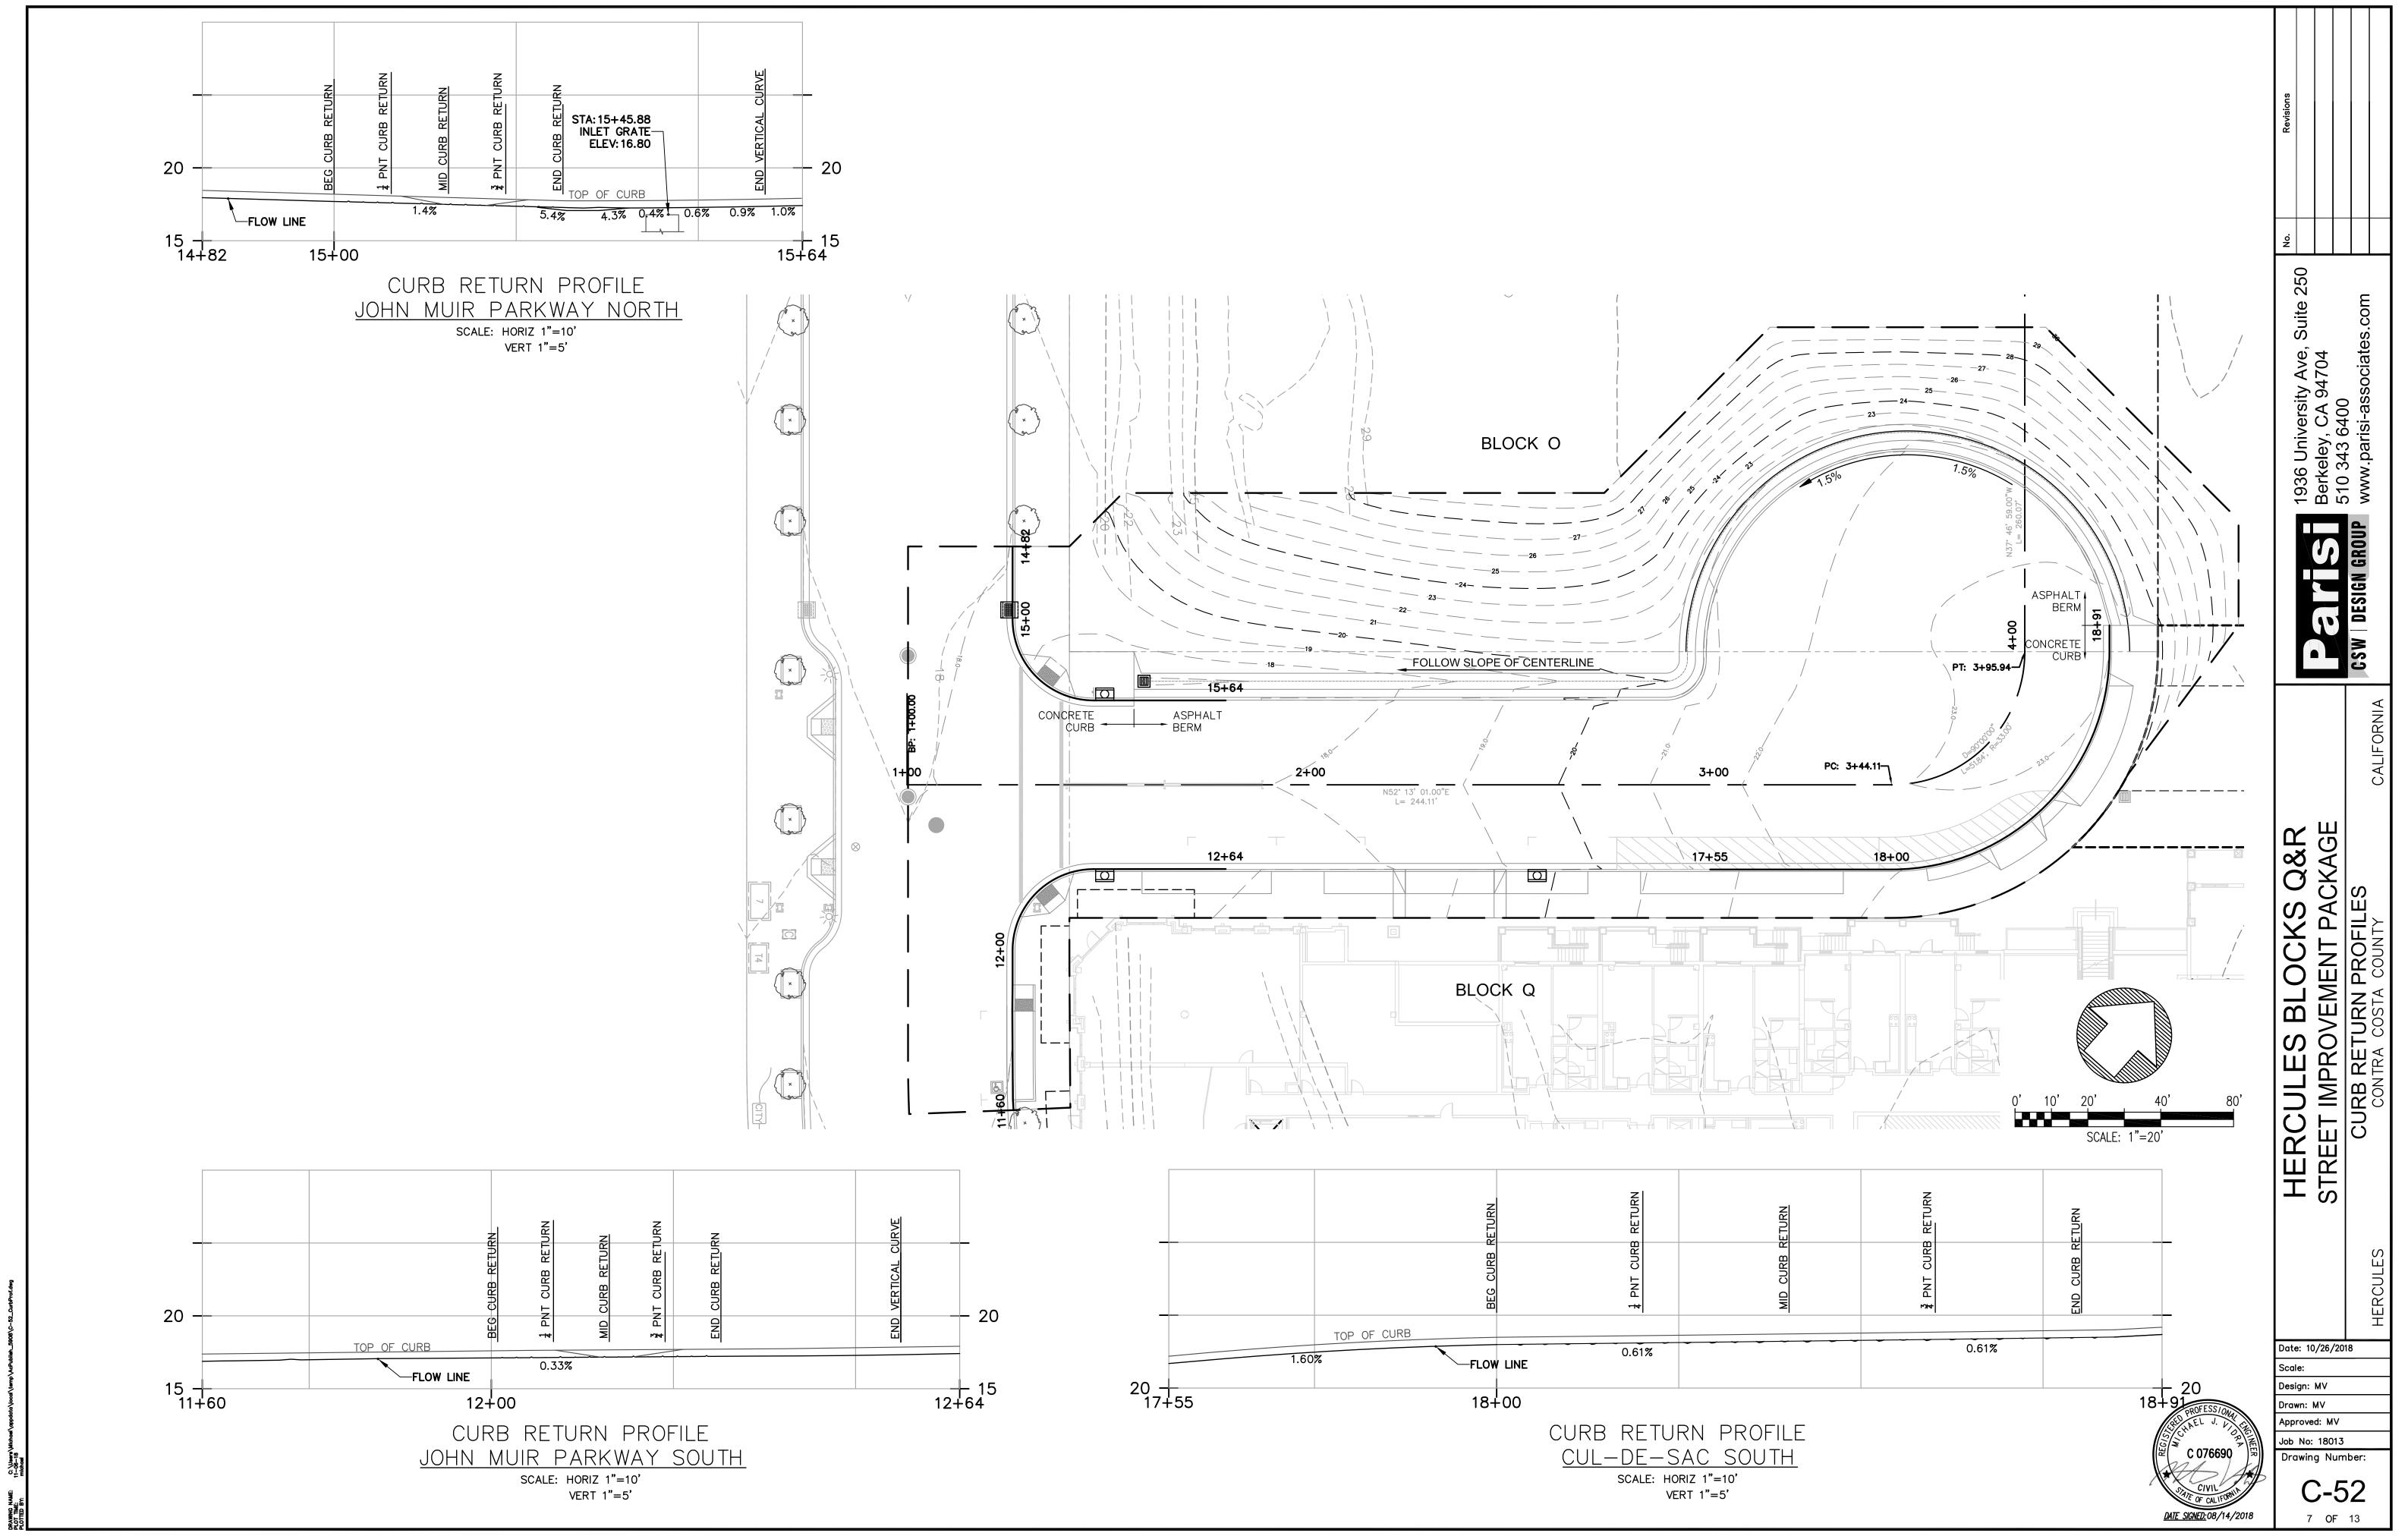





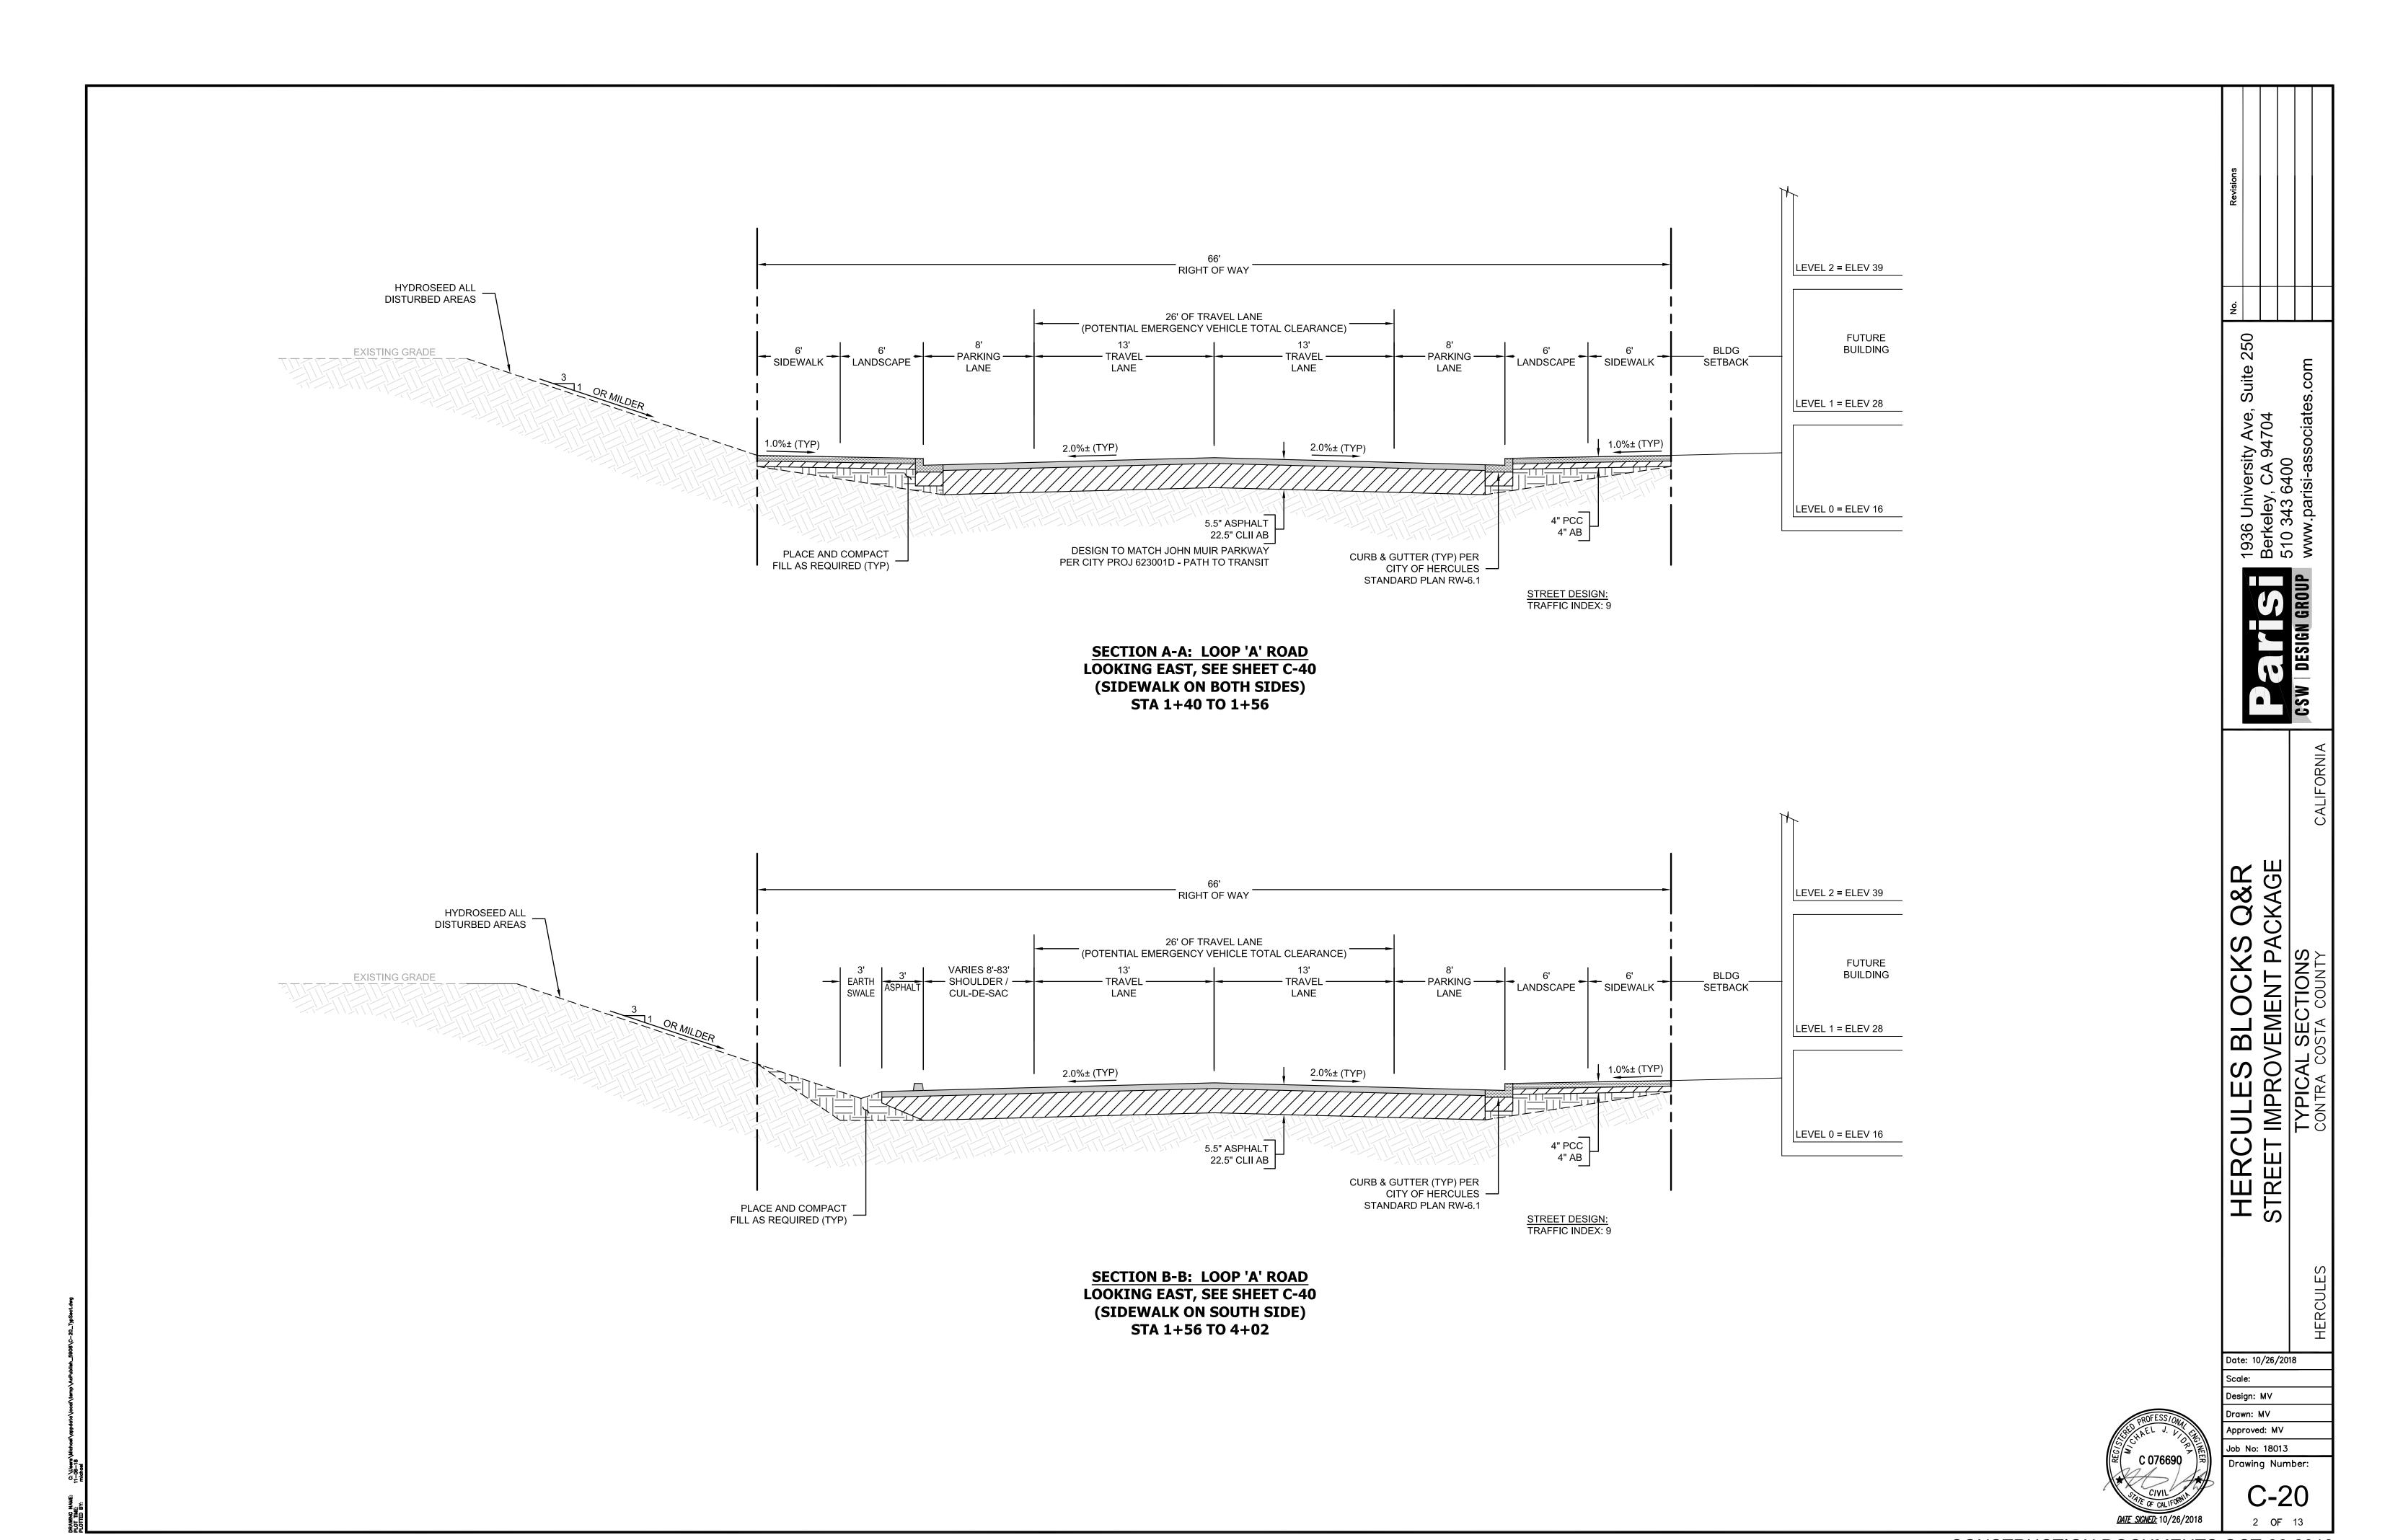


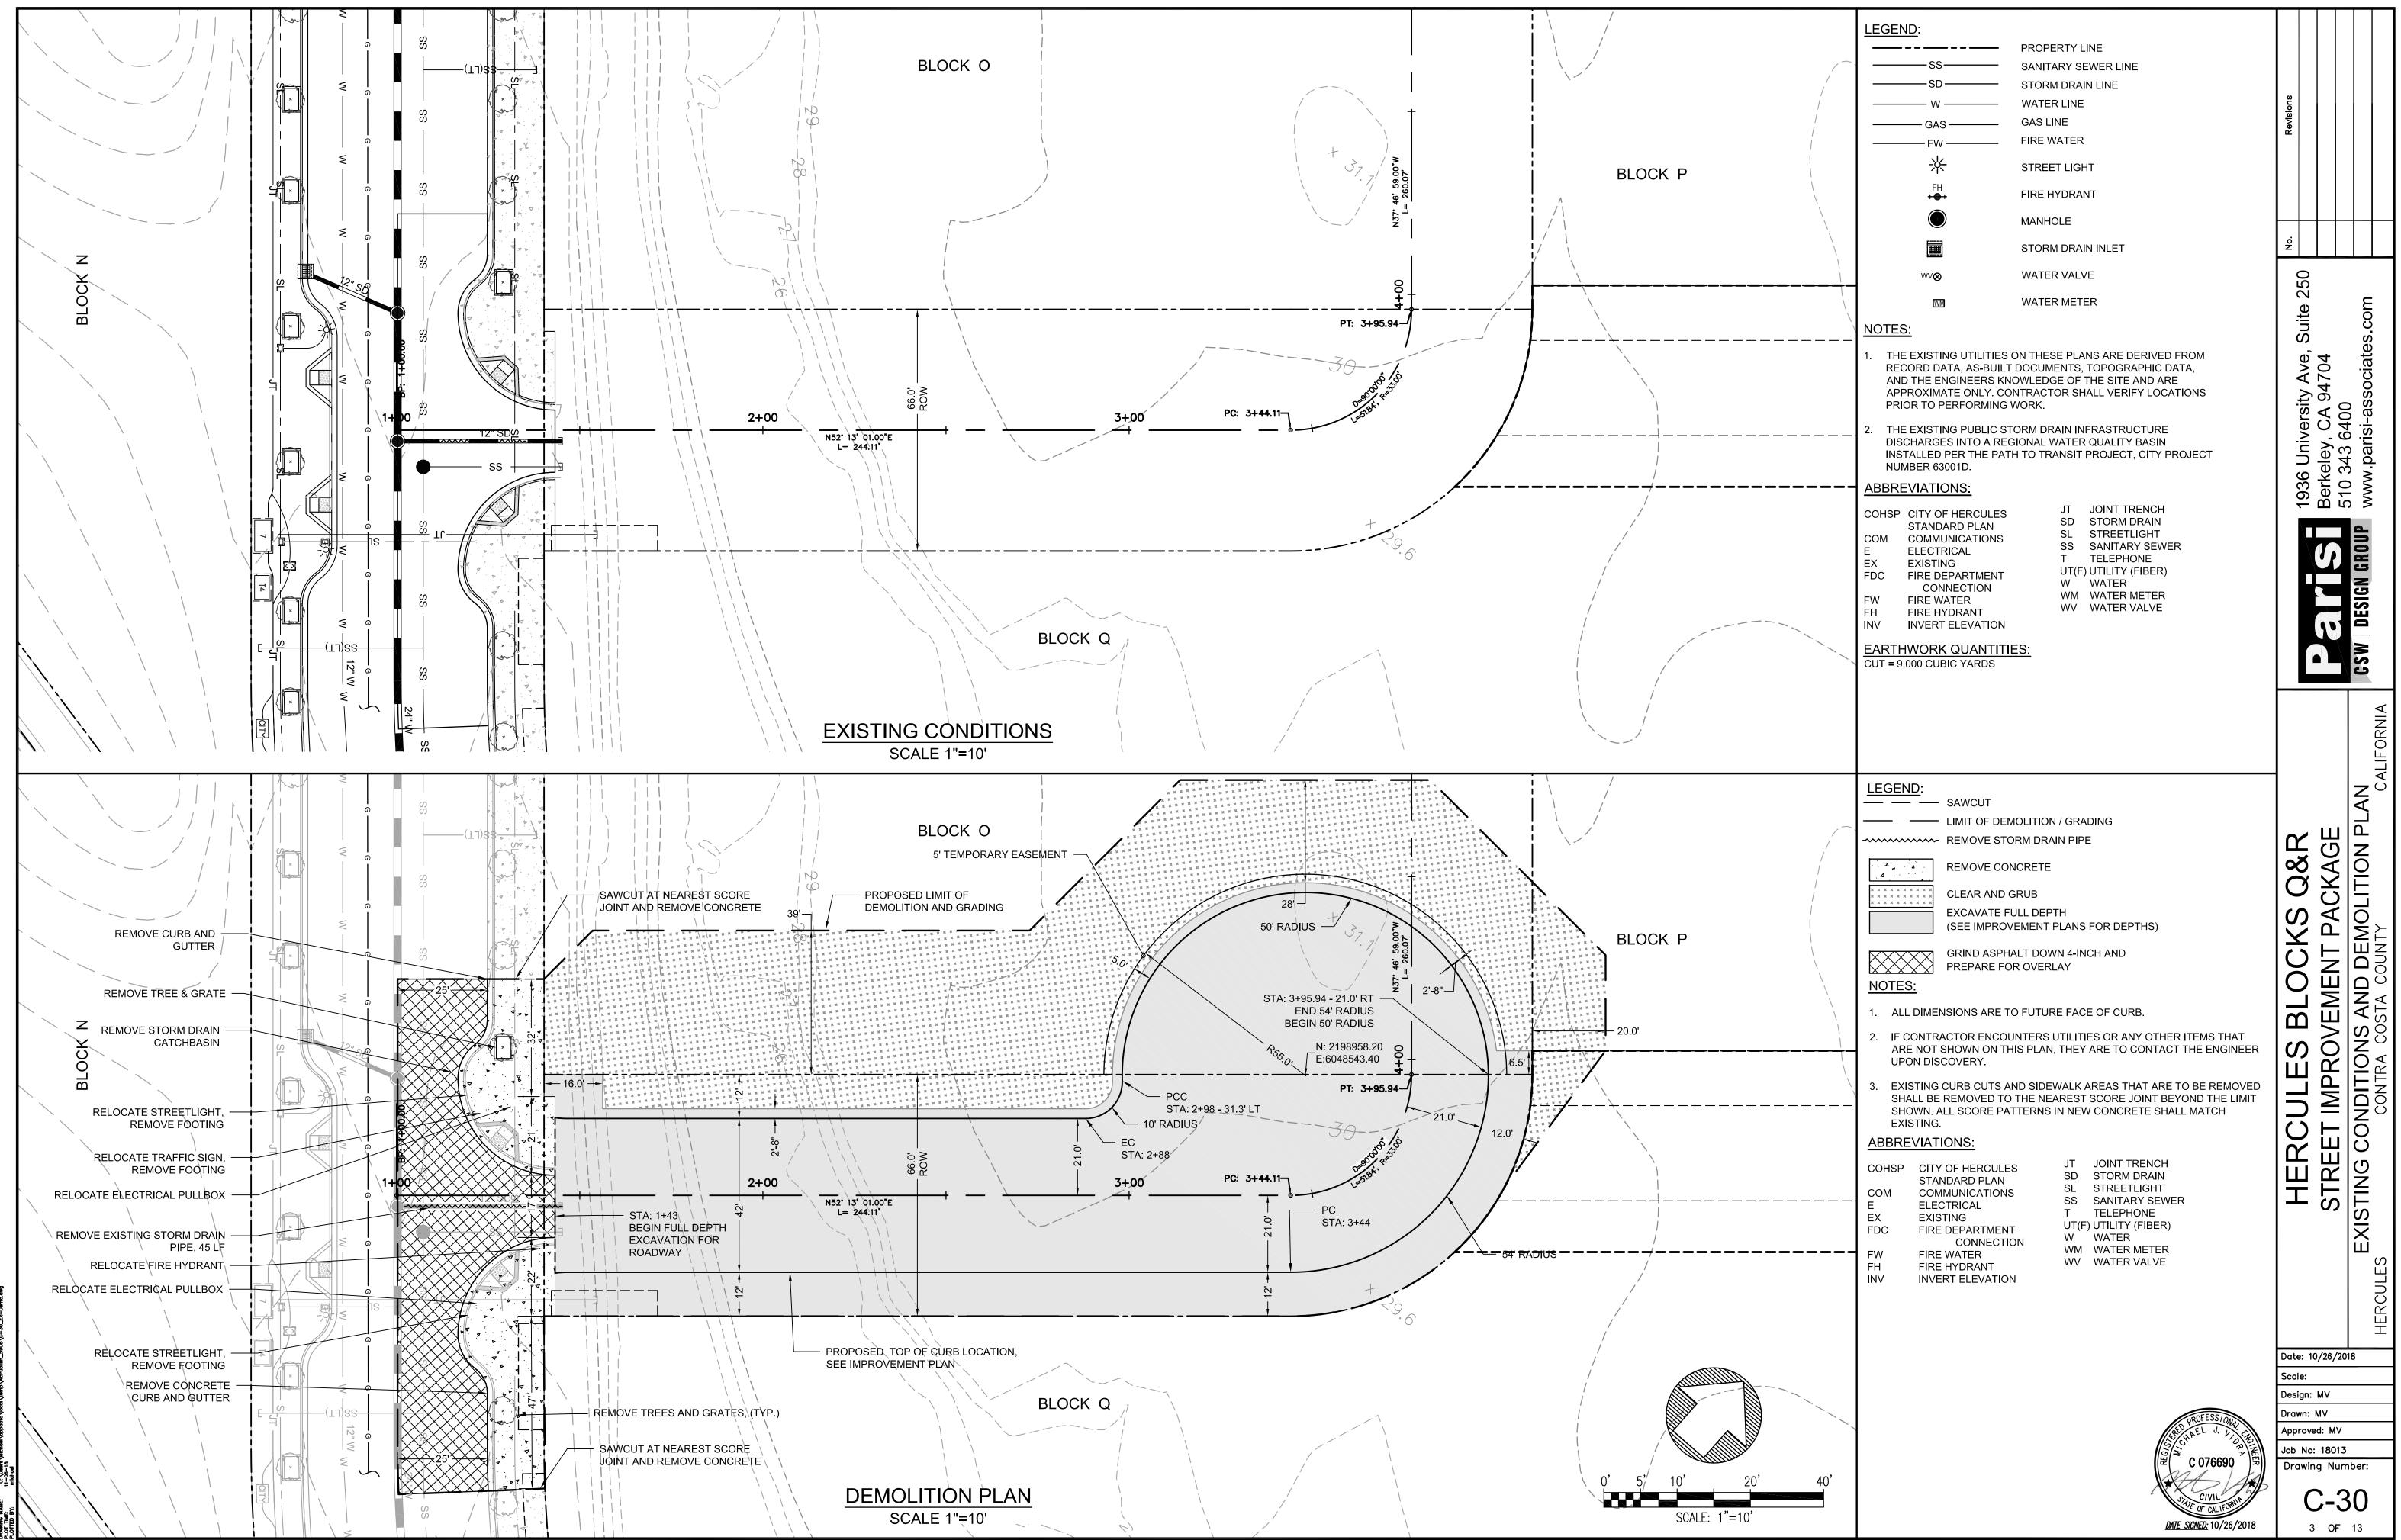


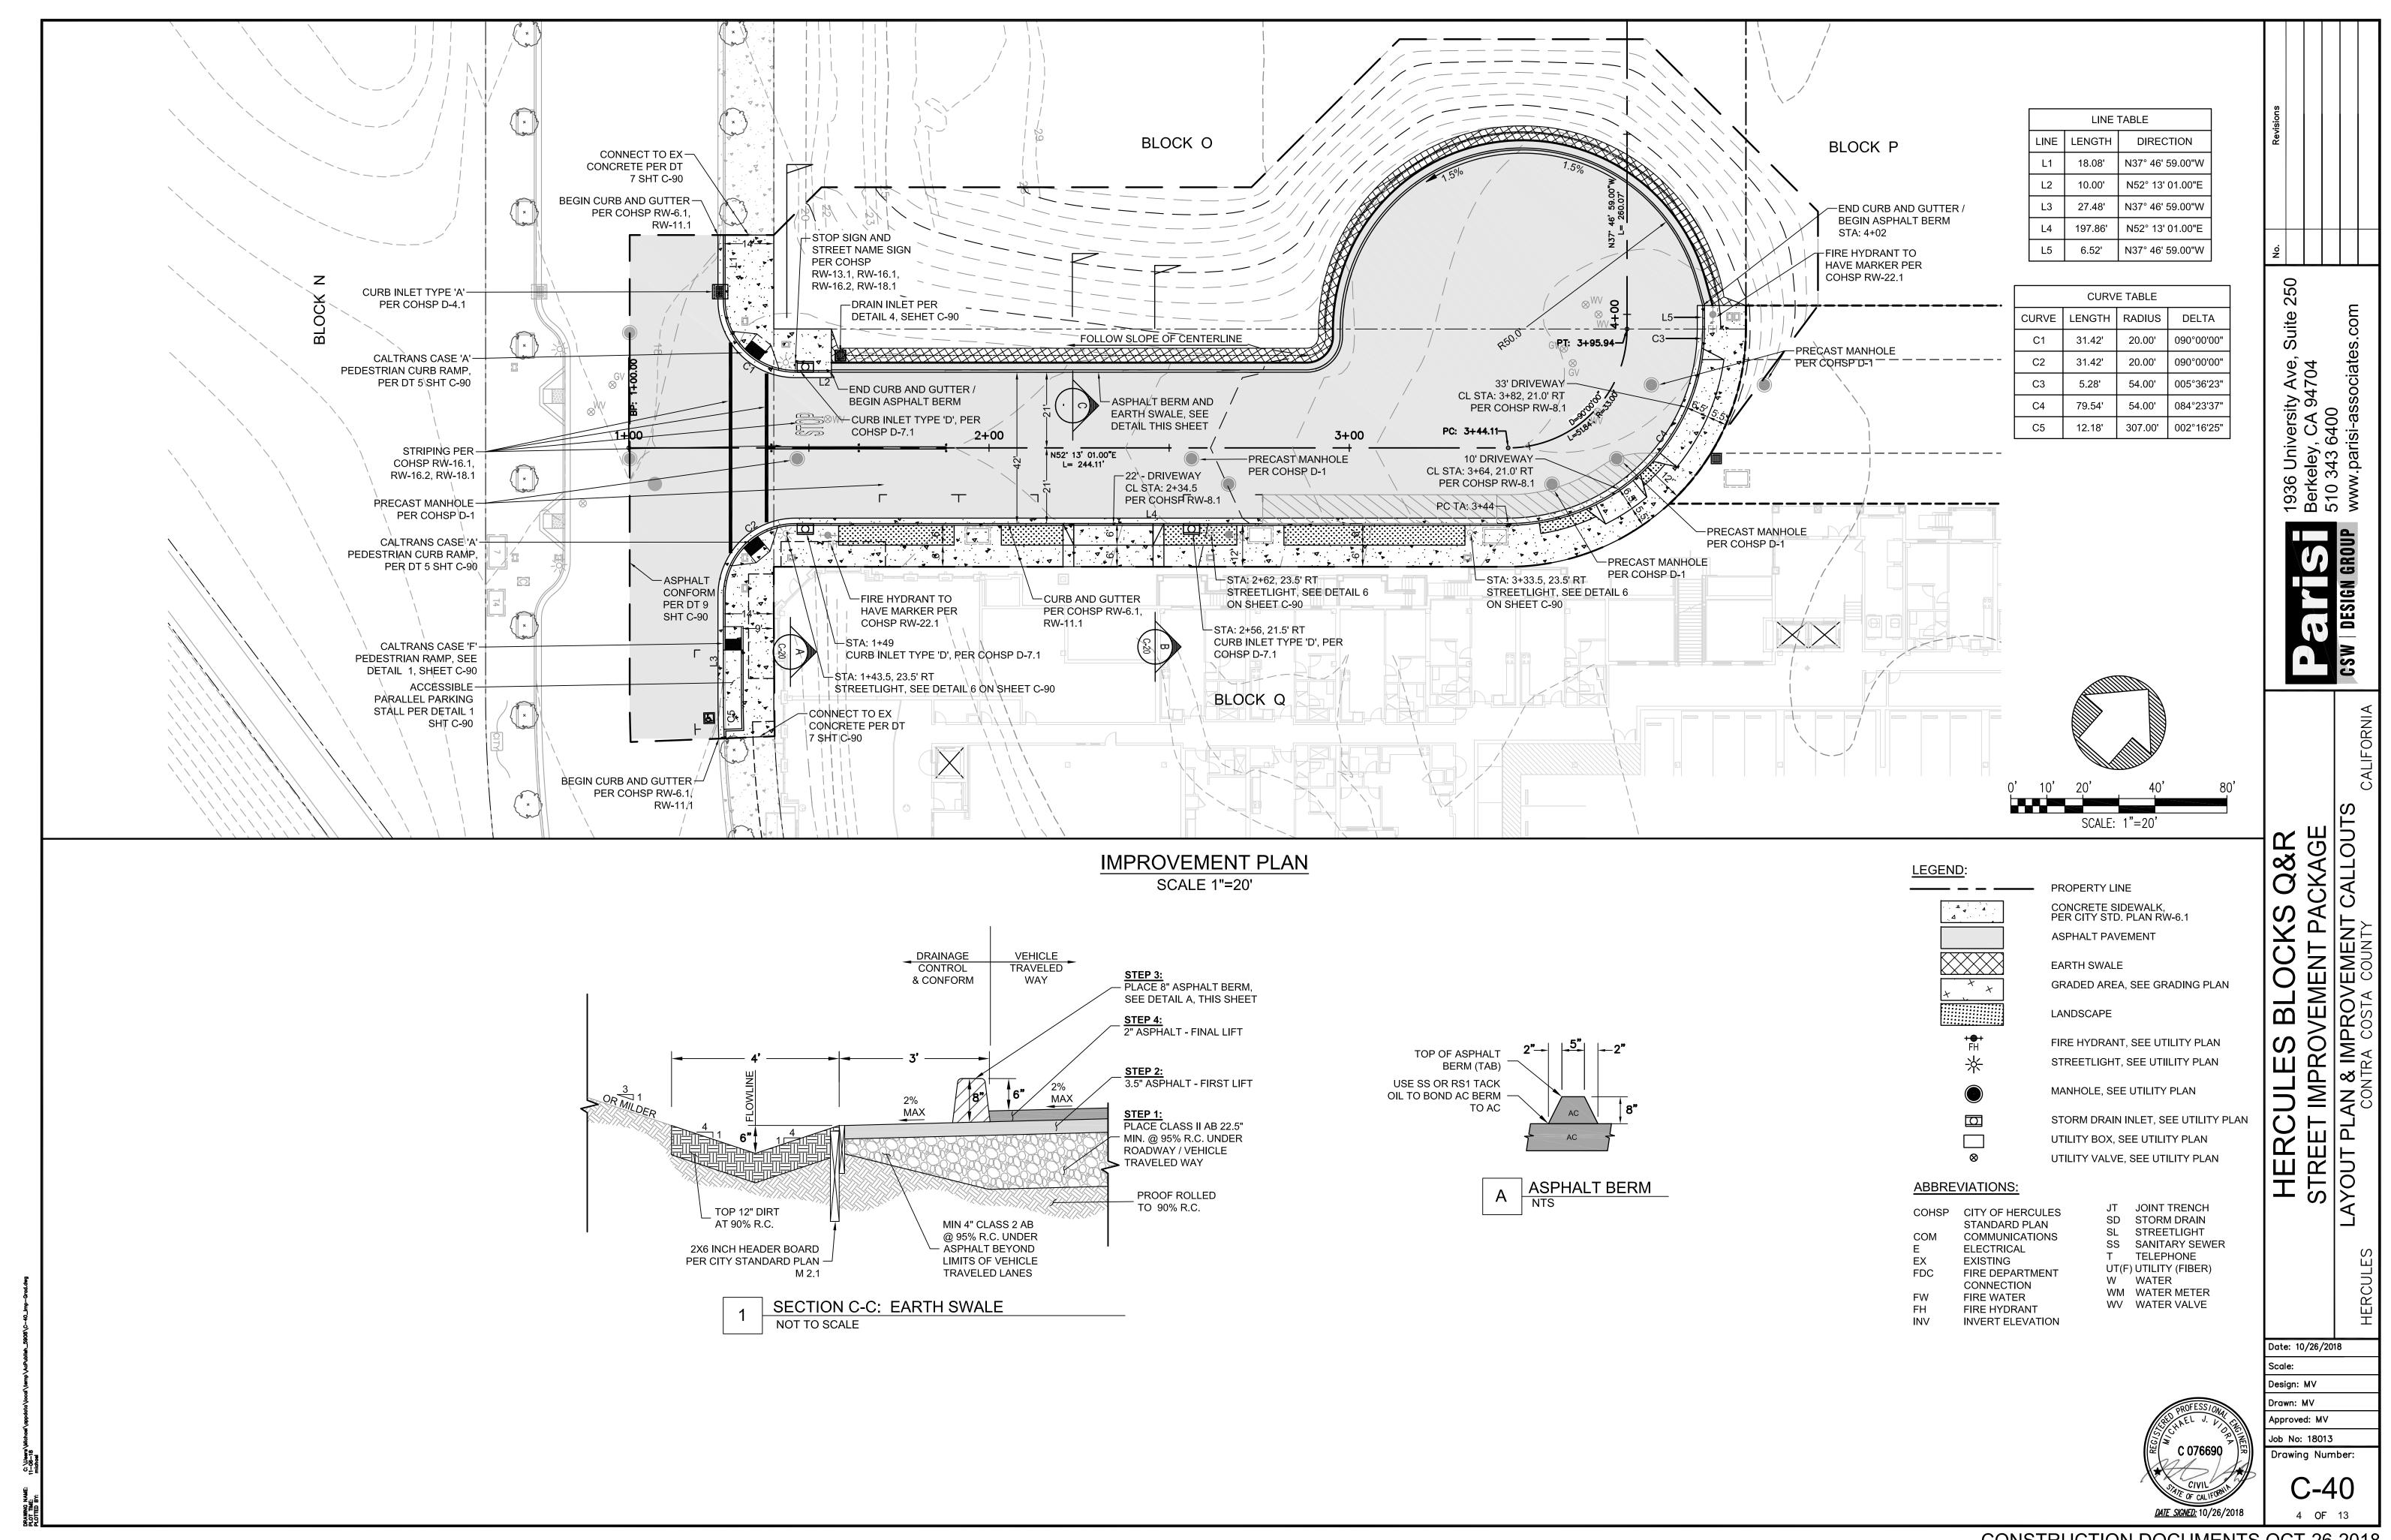

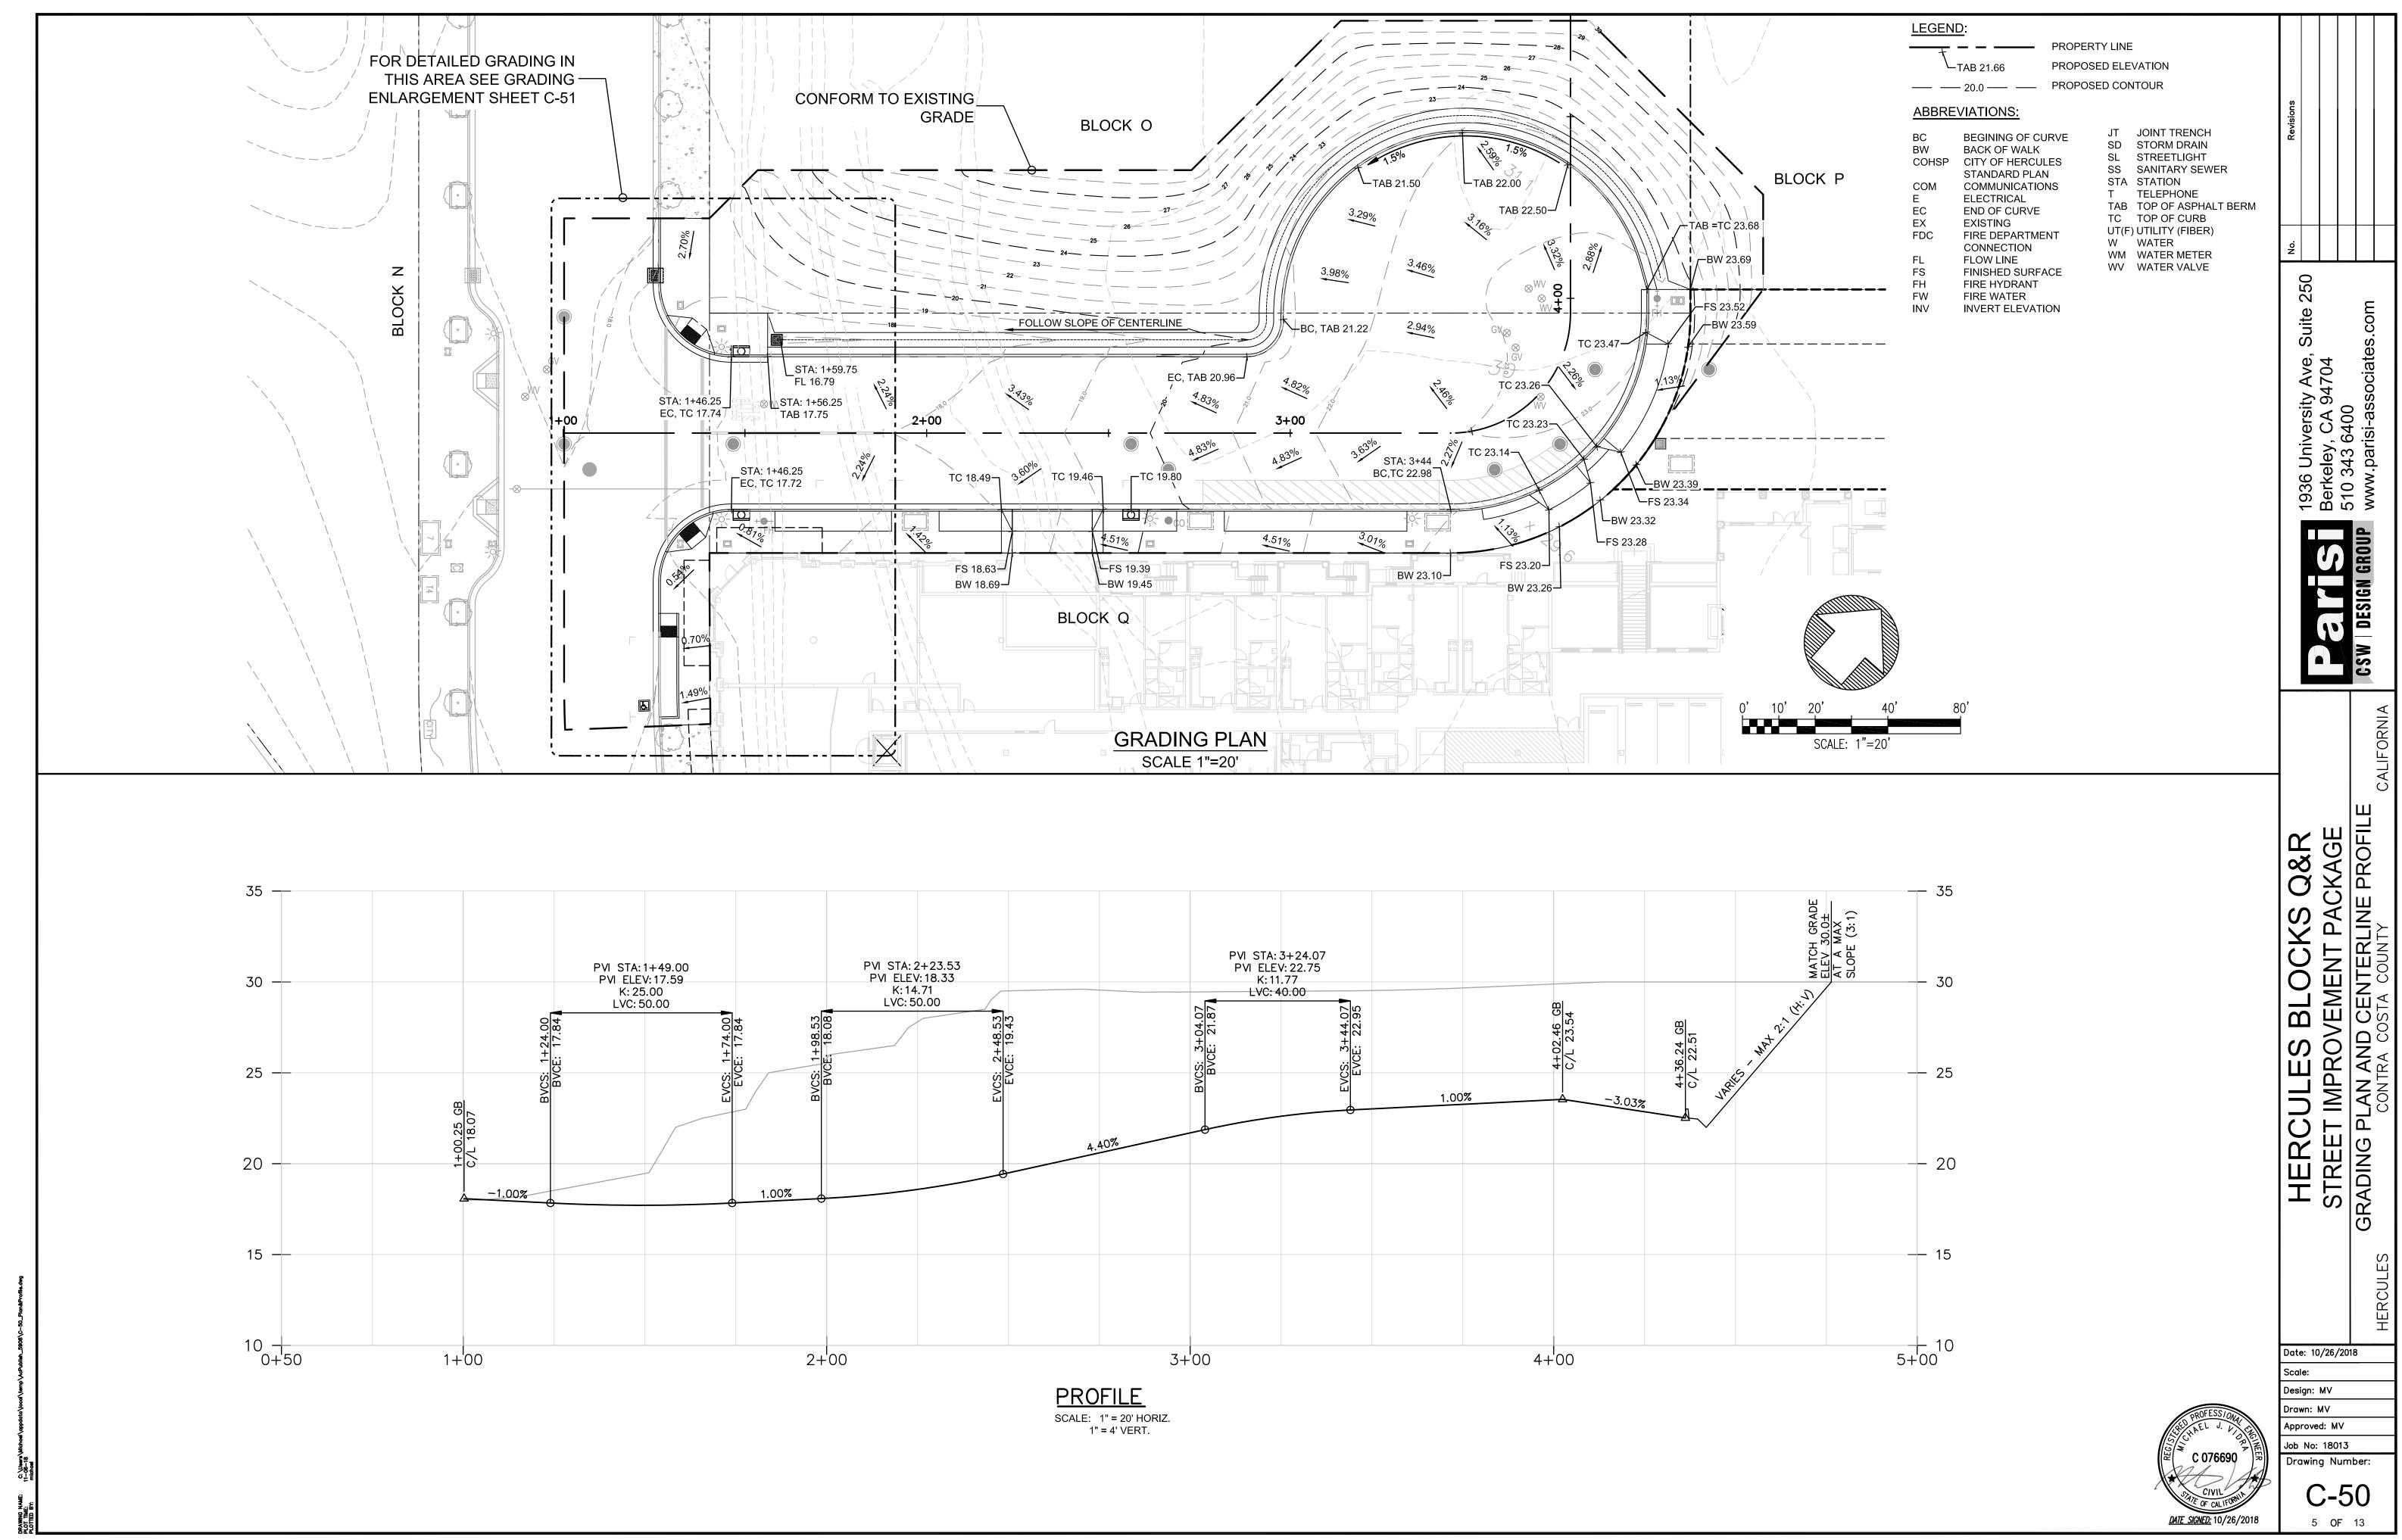

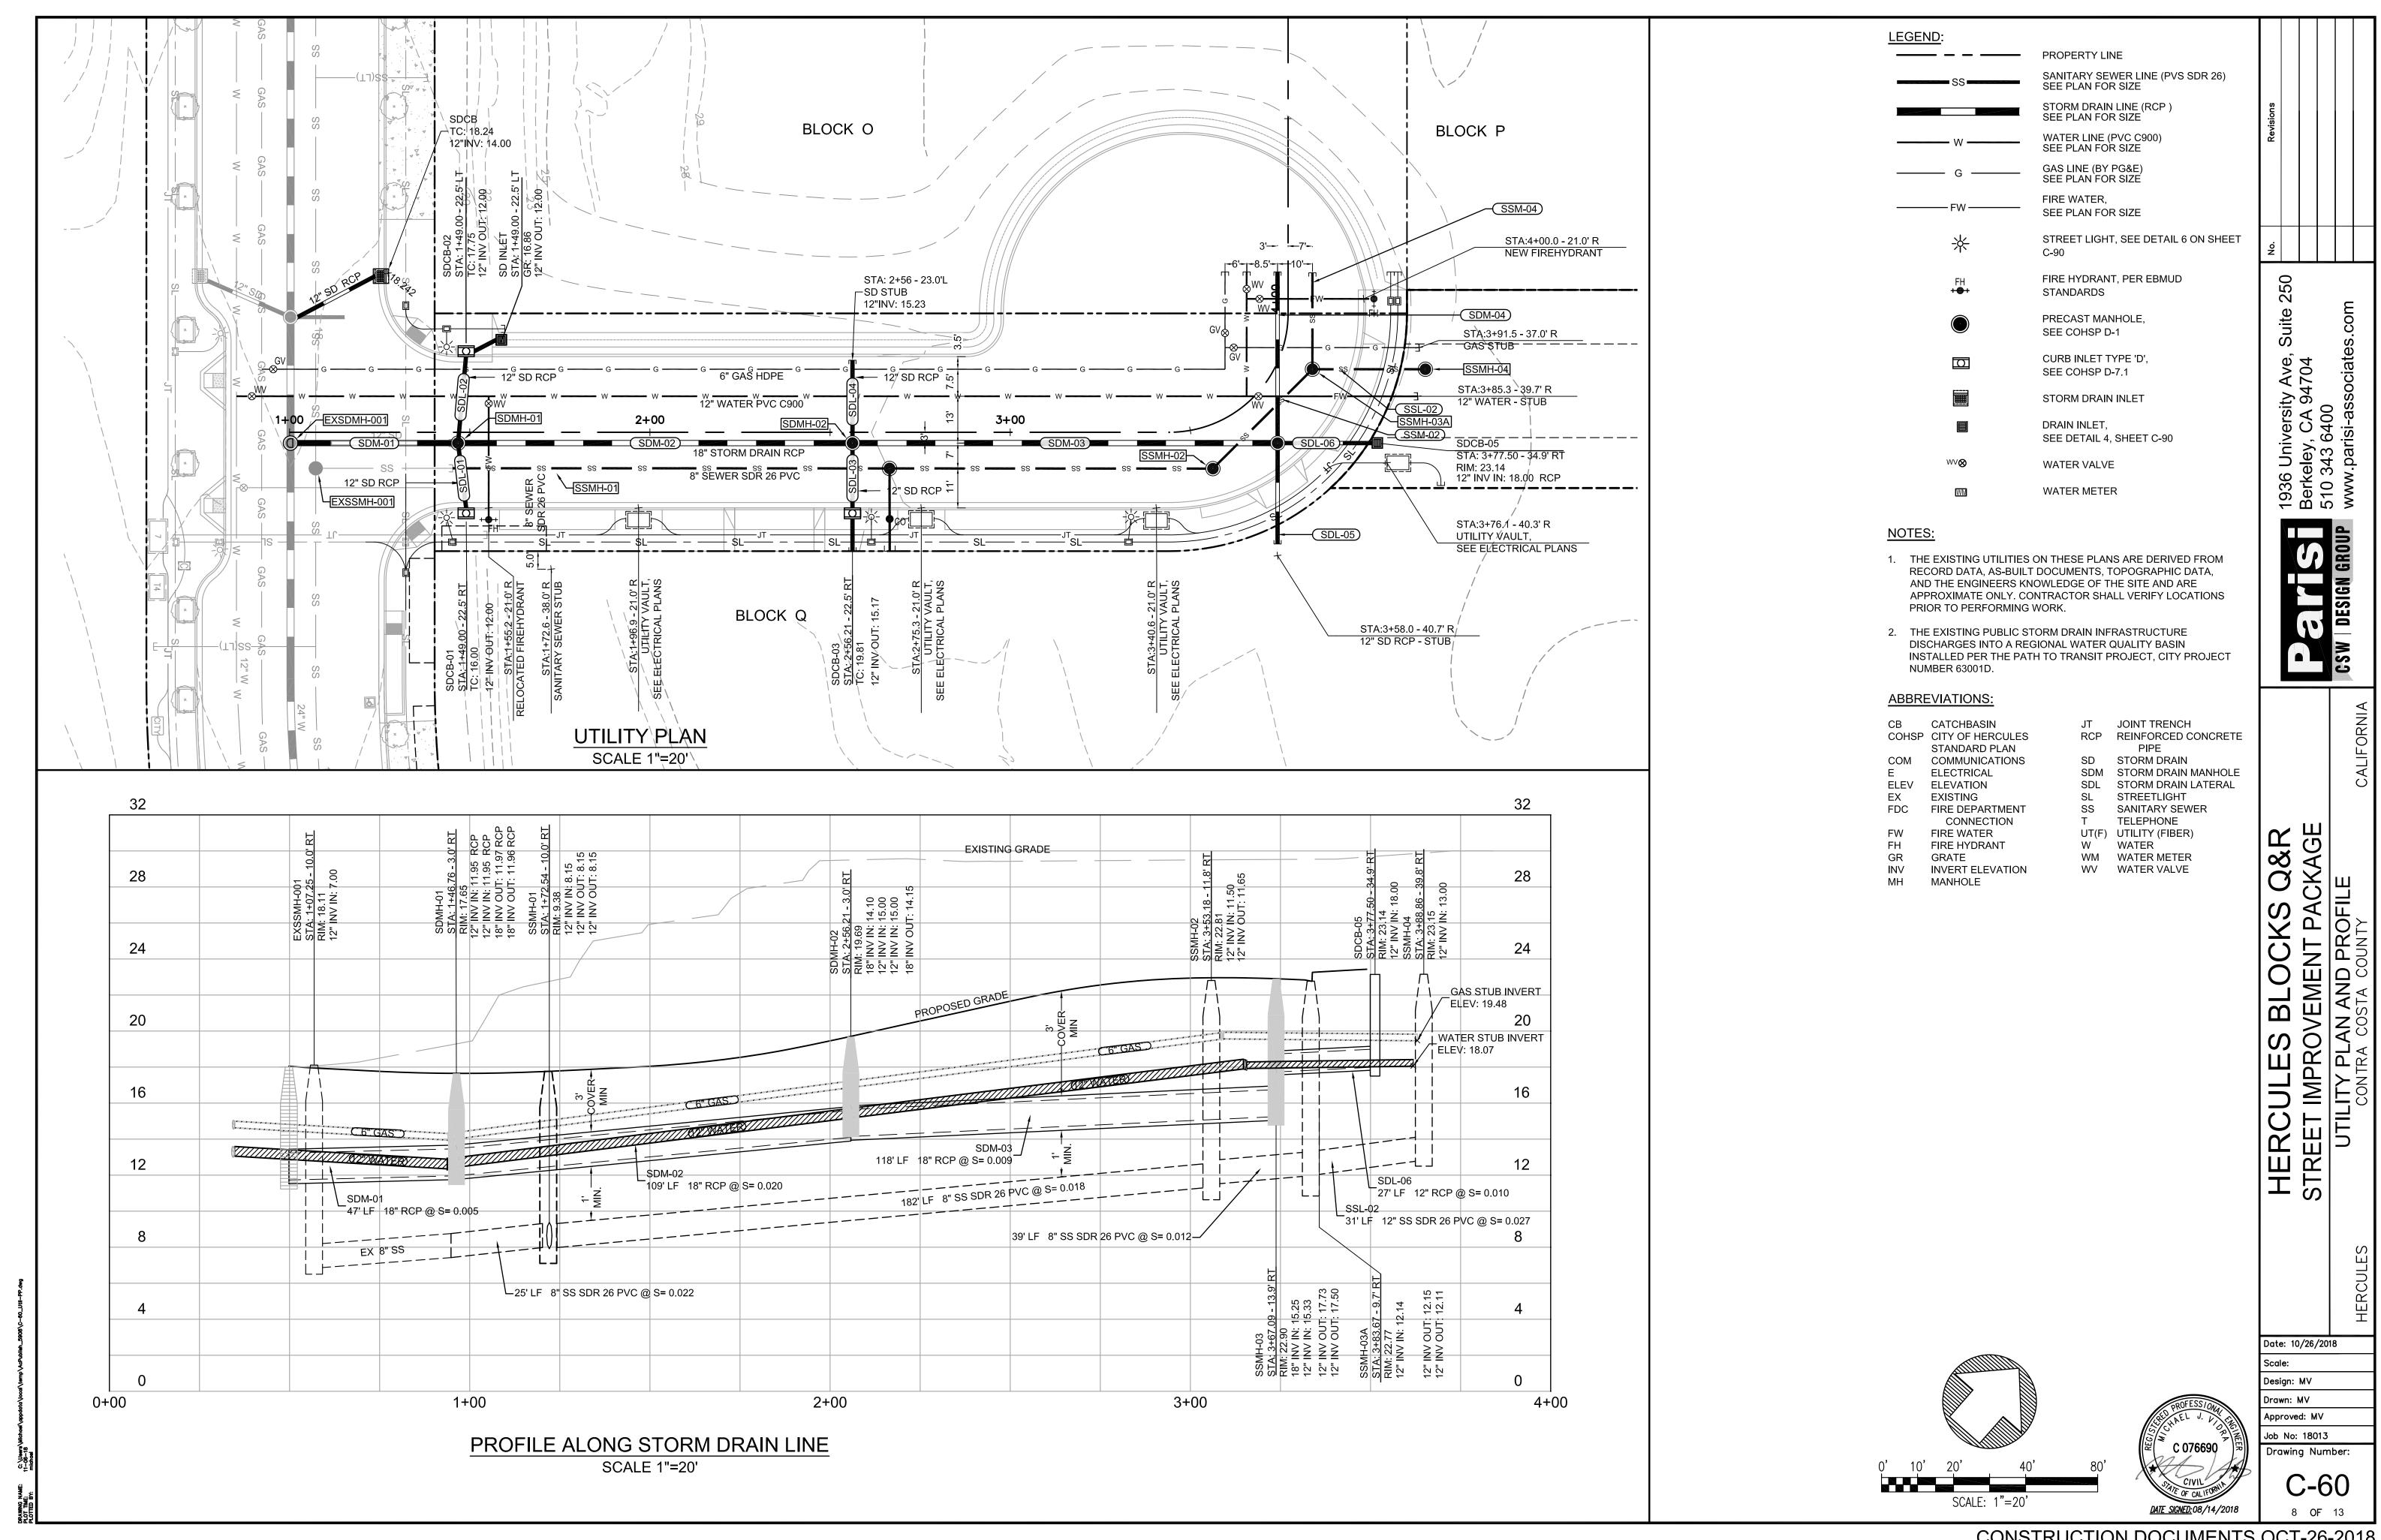

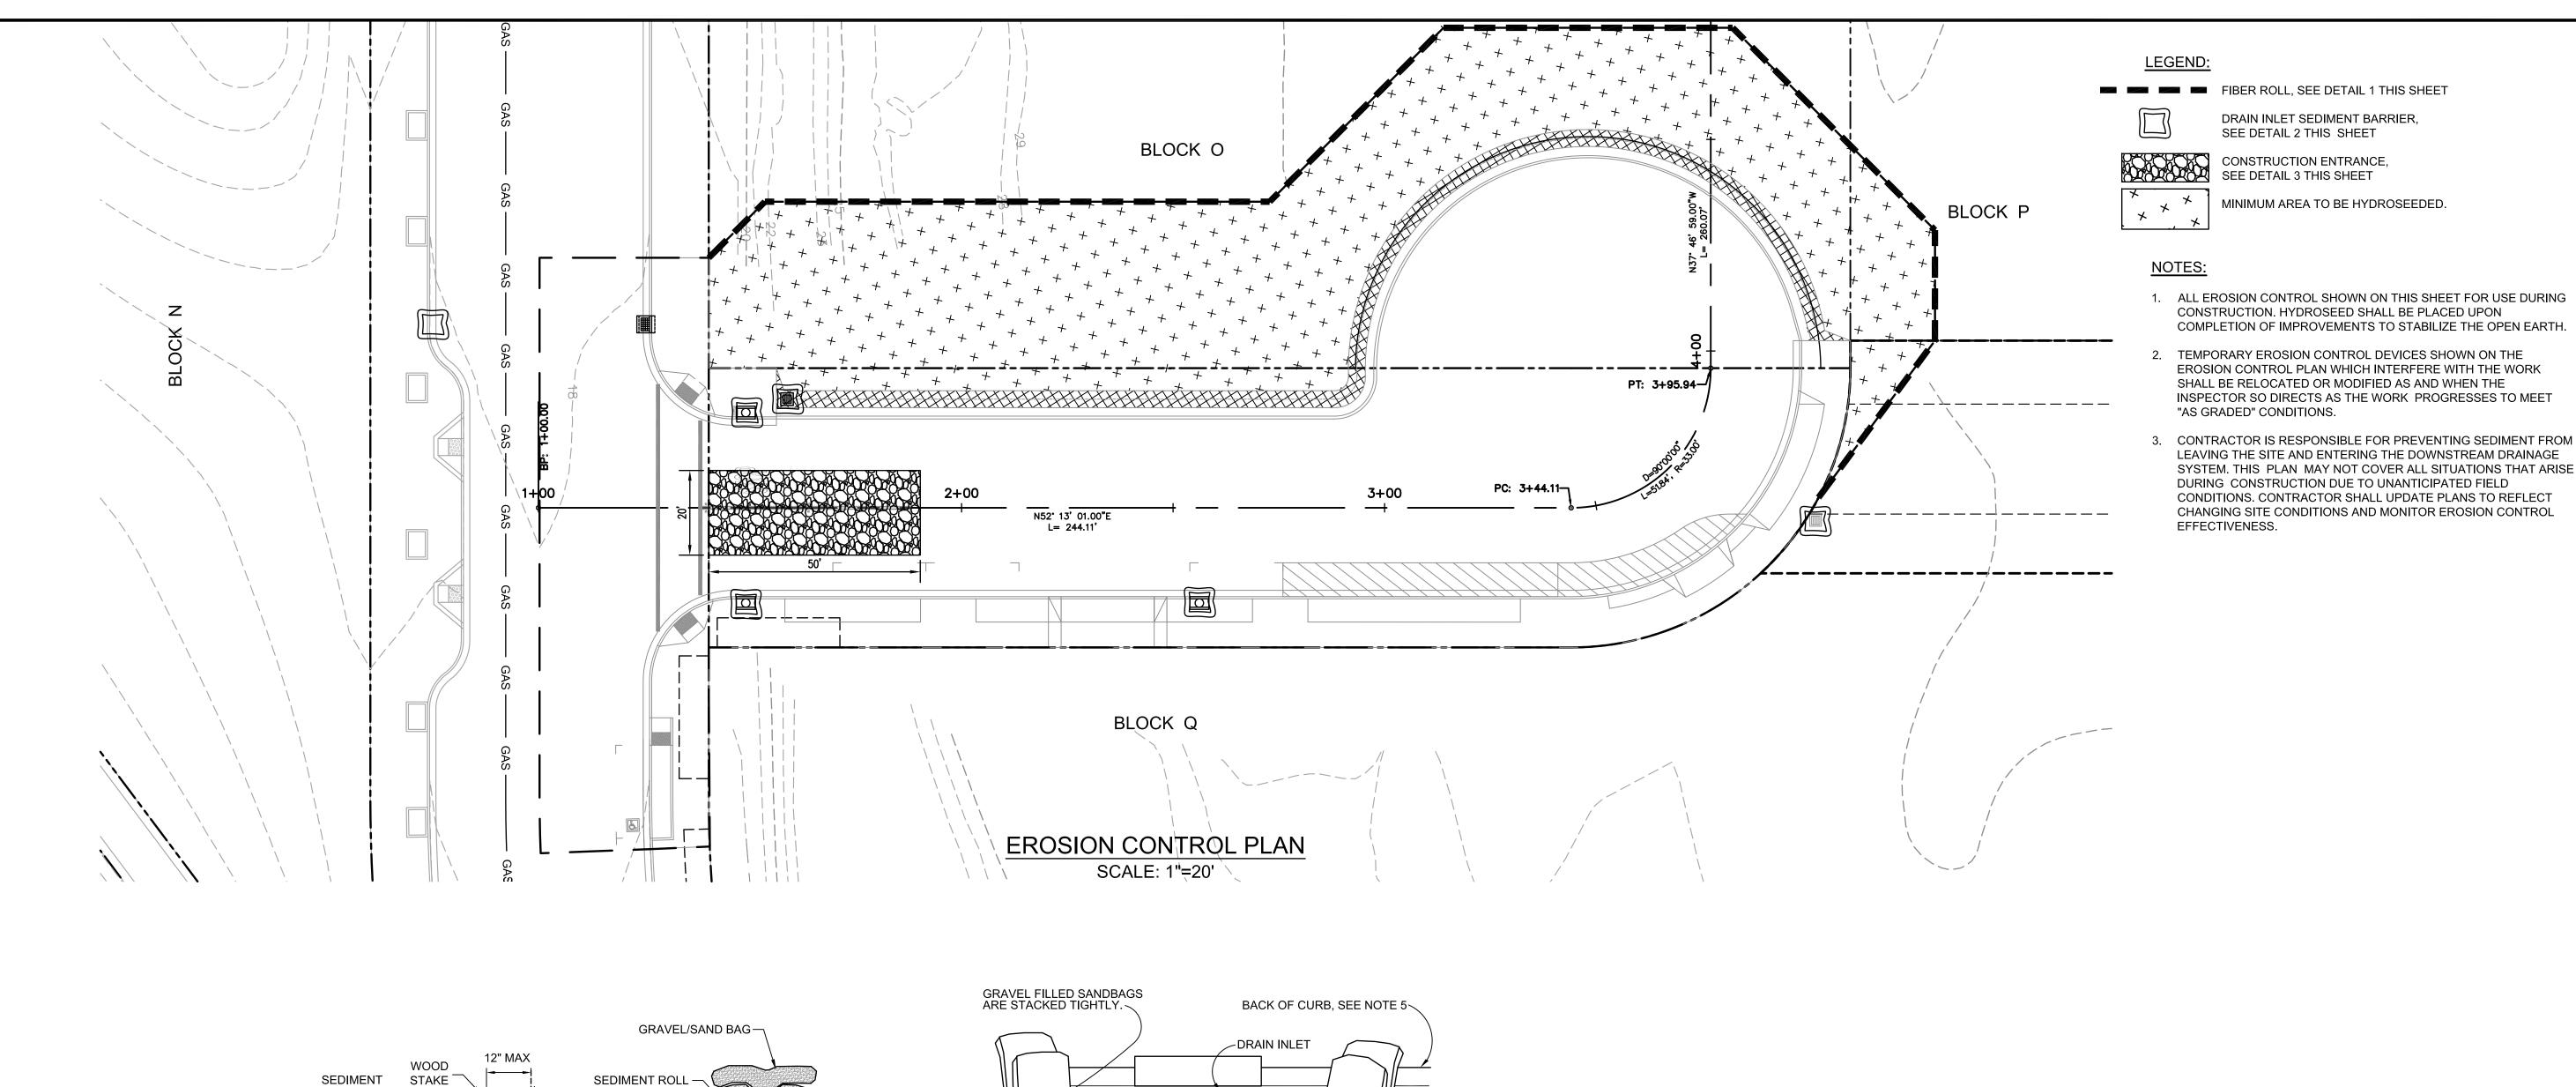

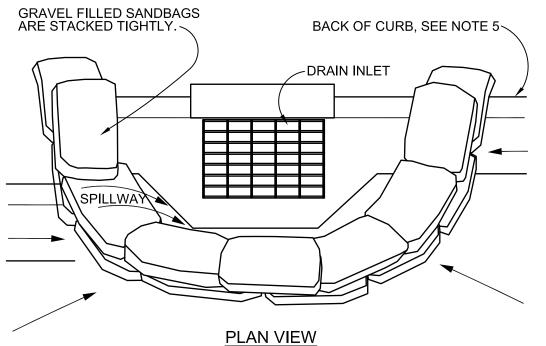

NOTES:

ROLL

FINISHED

LANDSCAPE

GRADE,-

- 1. FIBER ROLLS ARE TUBES MADE FROM POROUS BIODEGRADABLE FIBER STUFFED IN A PHOTO-DEGRADABLE OPEN WEAVE NETTING. THEY ARE APPROXIMATELY 8" DIAMETER.
- 2. FIBER ROLLS SHALL BE SECURED IN PLACE EITHER BY GRAVEL BAGS ON HARDSCAPE OR BY STAKING THE ROLL IN A TRENCH, 2"-4" DEEP, DUG ON CONTOUR IN LANDSCAPE. RUNOFF MUST NOT BE ALLOWED TO RUN UNDER OR AROUND ROLL. ROLLS SHOULD BE ABUTTED SECURELY TO PROVIDE A TIGHT JOINT, NOT OVERLAPPED.
- 3. TURN ENDS OF FIBER ROLLS UPSLOPE.
- 4. SILT BUILD-UP AT THE UPSLOPE SIDE OF FIBER ROLLS SHALL BE REMOVED WHEN THE DEPRESSION BECOMES 50% FULL.
- 5. ANY PLACE WHERE WATER HAS ERODED UNDER THE FIBER ROLL SHALL BE IMMEDIATELY FILLED AS NECESSARY TO PREVENT RECURRENCE.

FINISHED

GRADE,

HARDSCAPE

ENTRENCHMENT DETAIL

IN FLAT AREA

1 FIBER ROLLS SCALE: NTS

- 1. PLACE CURB TYPE SEDIMENT BARRIERS ON GENTLY SLOPING STREET SEGMENTS, WHERE WATER CAN POND AND ALLOW SEDIMENT TO SEPARATE FROM RUNOFF.
- 2. SANDBAGS OF EITHER BURLAP OR WOVEN 'GEOTEXTILE' FABRIC, ARE FILLED WITH GRAVEL LAYERED AND PACKED TIGHTLY.
- 3. LEAVE A ONE SANDBAG GAP IN THE TOP ROW TO PROVIDE A SPILLWAY FOR OVERFLOW.
- 4. INSPECT BARRIERS AND REMOVE SEDIMENT IMMEDIATELY BEFORE AND AFTER EACH STORM EVENT. SEDIMENT AND GRAVEL MUST BE REMOVED FROM THE TRAVELED WAY IMMEDIATELY.
- 5. FOR INLETS NOT AGAINST A CURB, PLACE GRAVEL FILLED SANDBAGS FULLY SURROUNDING THE INLET, IN SIMILAR PATTERN, LEAVING A SPILLWAY EVERY THIRD BAG.

DRAIN INLET SEDIMENT BARRIER SCALE: NTS


EROSION CONTROL DETAILS

SCALE: NTS

 $\bar{\ }$ SHOWN ON PLAN $\bar{\ }$ EXIST. — GROUND L L EXISTING PAVEMENT INSTALL 3" TO 6" DURABLE CRUSHED ROCK OR EQUIV. GEOTEXTILE FILTER FABRIC -

TEMPORARY STABILIZED CONSTRUCTION ENTRANCE

SCALE: NTS

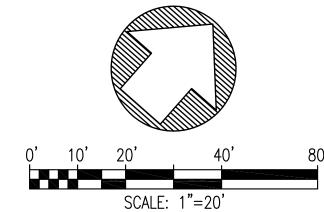


FIBER ROLL, SEE DETAIL 1 THIS SHEET

MINIMUM AREA TO BE HYDROSEEDED.

DRAIN INLET SEDIMENT BARRIER, SEE DETAIL 2 THIS SHEET



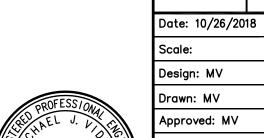

Design: MV rawn: MV pproved: MV ob No: 18013

Drawing Number:

DATE SIGNED: 10/26/2018 9 **OF** 13

